

TYPE	WIDTH	HEIGHT	DESCRIPTION
W1	3.00	2.15	WOODEN MAIN DOOR
W2	1.24	2.15	DO
D	0.70	2.15	WOODEN FLAP DOOR
W3	1.24	1.87	DO
W4	1.24	1.87	WOODEN GLAZED WINDOW
W5	1.24	1.87	DO
W6	1.24	1.87	DO
W7	1.24	1.87	DO
W60	1.24	1.87	DO
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W62	1.24	1.87	DO
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W64	1.24	1.87	DO
W65	1.24	1.87	DO
W66	1.24	1.87	DO
W67	1.24	1.87	DO
W68	1.24	1.87	DO
W69	1.24	1.87	DO
W70	1.24	1.87	DO
W71	1.24	1.87	DO
W72	1.24	1.87	DO
W73	1.24	1.87	DO
W74	1.24	1.87	DO
W75	1.24	1.87	DO
W76	1.24	1.87	DO
W77	1.24	1.87	DO
W78	1.24	1.87	DO
W79	1.24	1.87	DO
W80	1.24	1.87	DO
W81	1.24	1.87	DO
W82	1.24	1.87	DO
W83	1.24	1.87	DO
W84	1.24	1.87	DO
W85	1.24	1.87	DO
W86	1.24	1.87	DO
W87	1.24	1.87	DO
W88	1.24	1.87	DO
W89	1.24	1.87	DO
W90	1.24	1.87	DO
W91	1.24	1.87	DO
W92	1.24	1.87	DO
W93	1.24	1.87	DO
W94	1.24	1.87	DO
W95	1.24	1.87	DO
W96	1.24	1.87	DO
W97	1.24	1.87	DO
W98	1.24	1.87	DO
W99	1.24	1.87	DO
W100	1.24	1.87	DO

SPECIFICATIONS

FOUNDATION: R.C.C. RAFT OVER A LAYER OF R.C.C. SAND FILLING.

SUPERSTRUCTURE: R.C.C. FRAME WORK WITH BRICK WORK IN CM 1:1:6. R.C.C. ROOF SLAB R.C. LINTELS SCHEDULED R.A.D. BEAMS IN R.C.C. WITH SUITABLE REINFORCEMENTS.

FLOORING: MOSAIC FLOORING IN CM 1:1:6.

PLASTERING: 3 FINISHED WITH CEMENT PAINT.

WEATHERING COURSE: BRICK JELLY KING CONCRETE LAID IN SLOPE WITH CRUDE OIL IMPREGNATED TERRACE TILES.

NOTE: DIMS 300mm TO BE IDENTICAL UNLESS SPECIFIED OTHERWISE.

ELEVATION (COMPOUND WALL GATE DETAILS)

PLAN SCALE 0' 1" 0" (1:50)

KEY PLAN NOT TO SCALE

SECTION YY (RAIN WATER HARVEST DETAIL) SCALE: 1:100

COLOUR CODE REFERENCE

PROPOSED WORK ———

EXISTING ROAD ———

BOUNDARY ———

SEWER LINE ———

WATER LINE ———

MMDA B/PP NO. 7

DATE: 21/07/95

OWNER: S.P.A. HOLDERS

SIGNATURE OF OWNER: 20/1/95

SIGNATURE OF ARCHITECT





PROPOSED RESTAURANT AND RESIDENTIAL/OFFICE BUILDING AT T.T.K. ROAD, ALWARPET, MADRAS-600 049, T.S. NO. 1645/3, BLOCK NO. 34, DIVISION NO. 116.

FLOOR PLANS, ELEVATION, SECTION, SITE PLAN & KEY PLAN, ETC.


SCALE: 0' 1" 0" (1:100) DATE: 4.9.95 DRAWN: J.V.

ARCHITECTS


SELVARAJAN & ASSOCIATES
NO. 3, SARANGAPANI STREET, T. NAGAR, MADRAS-60

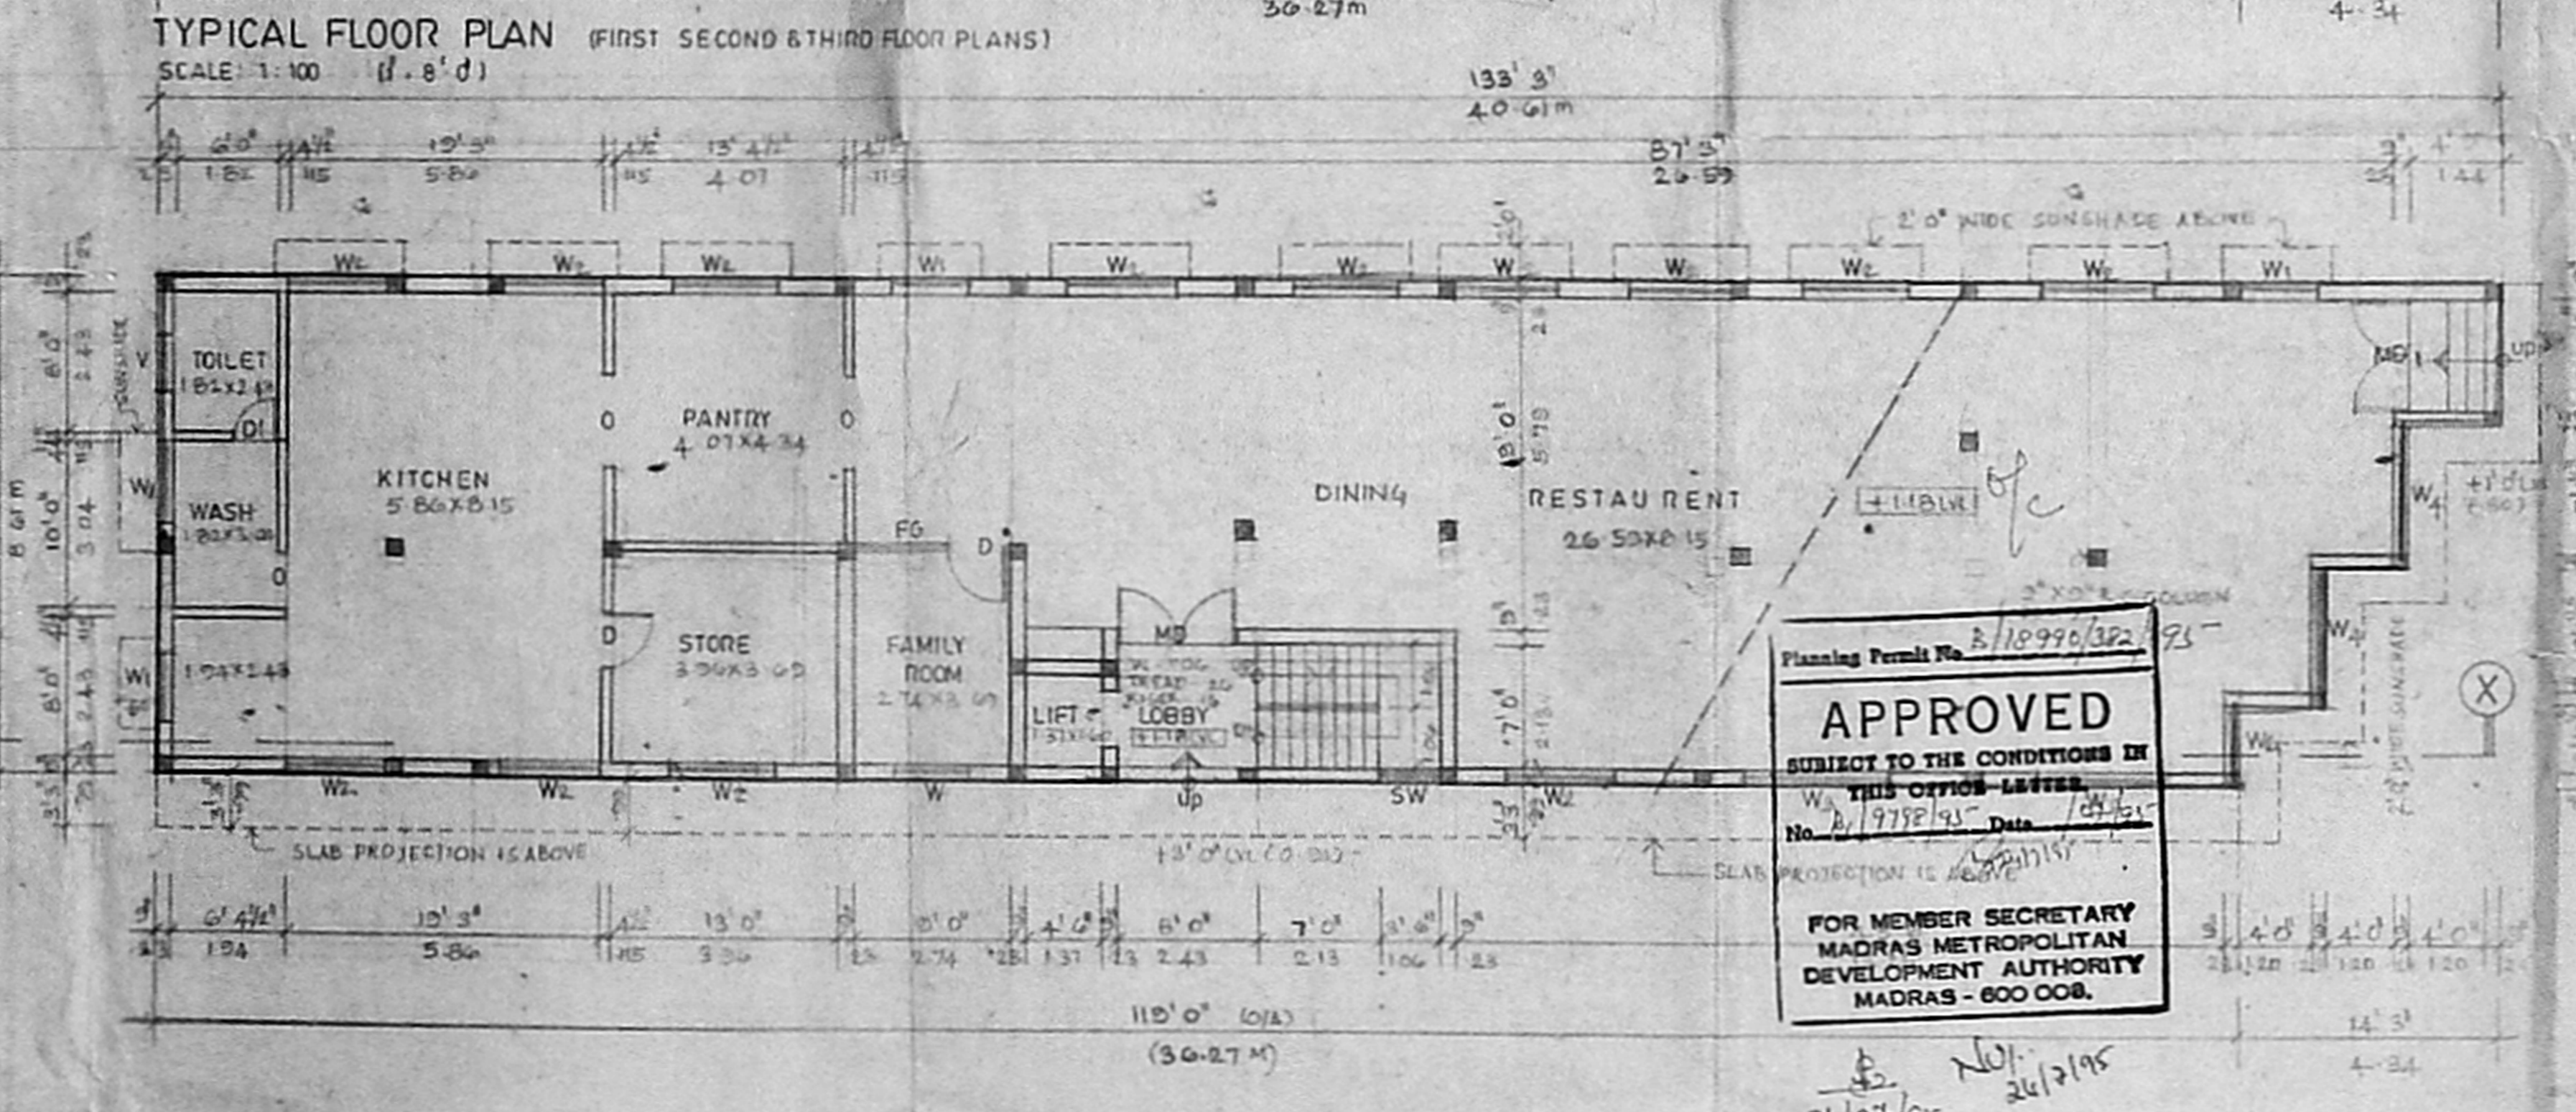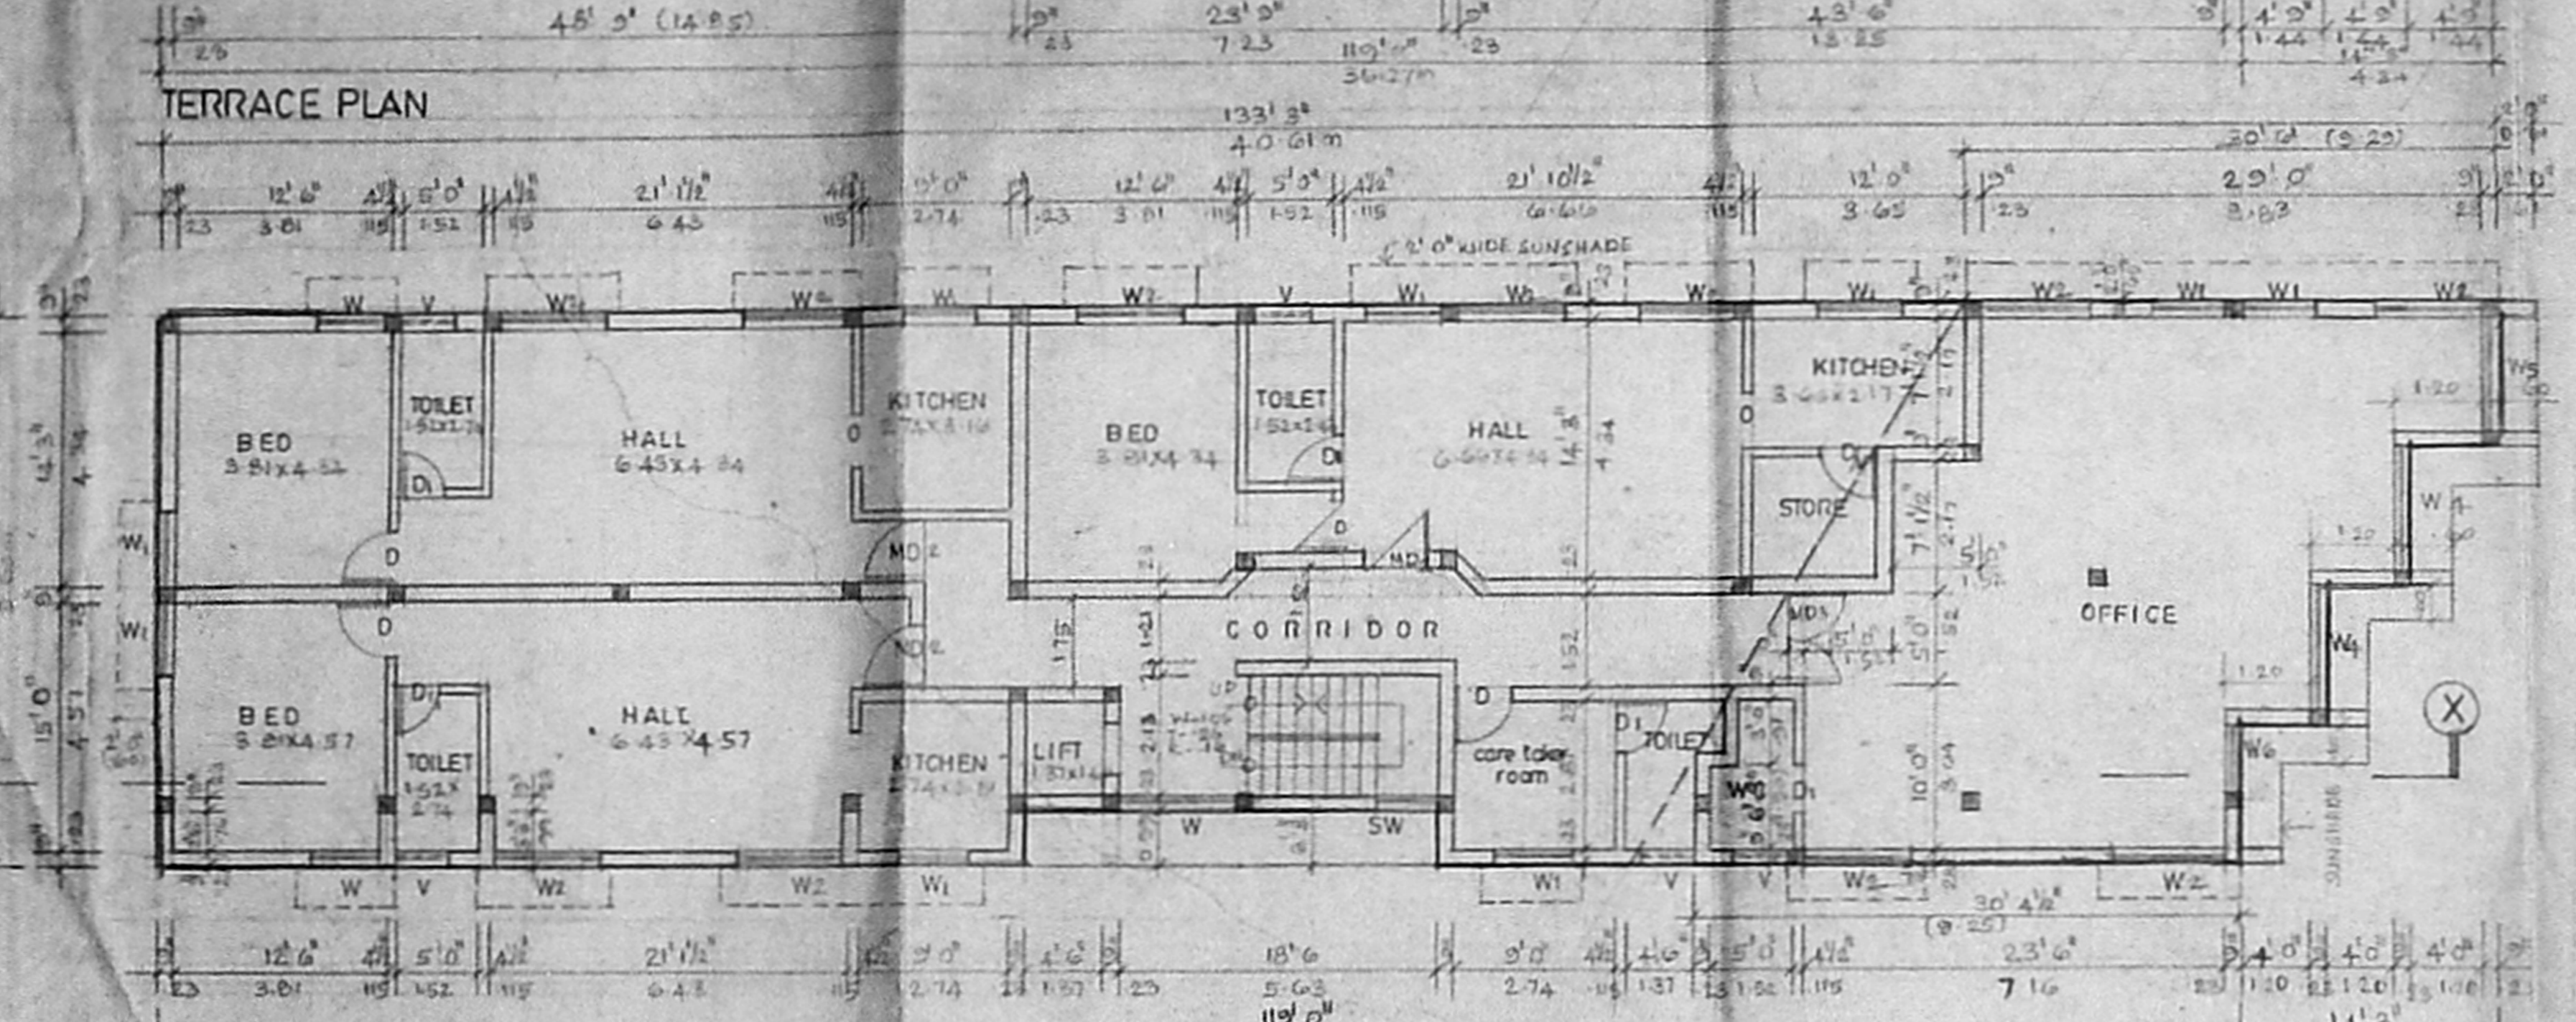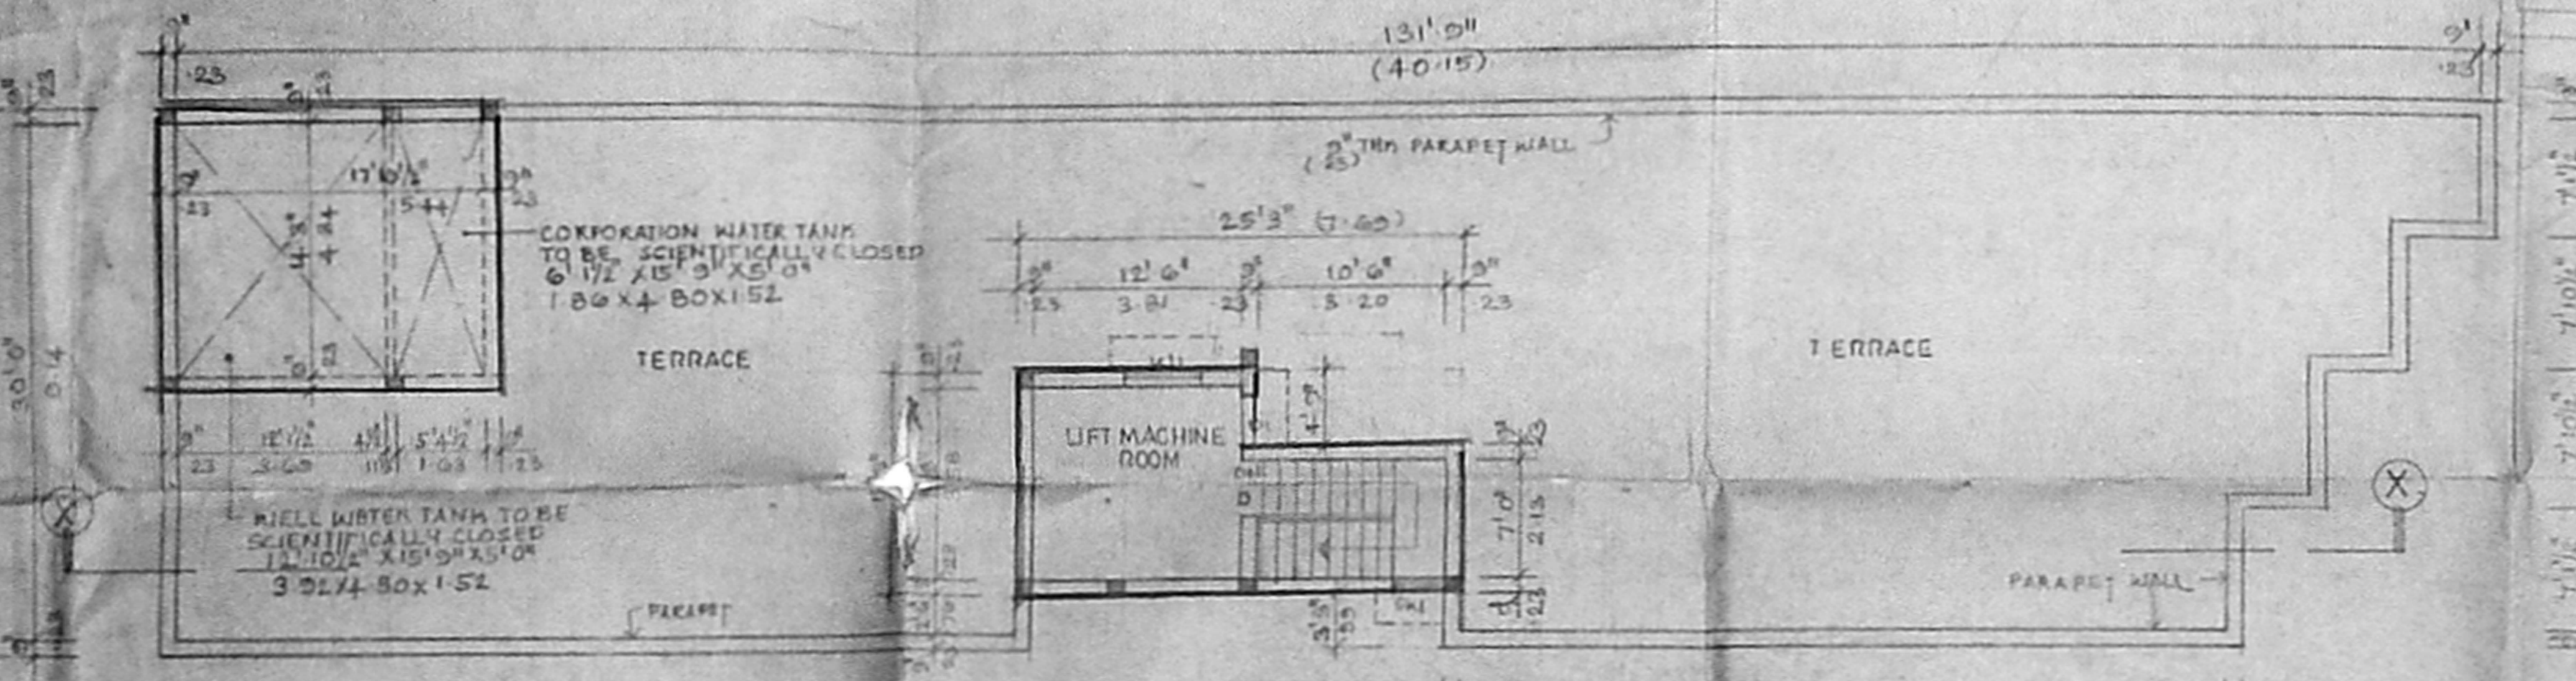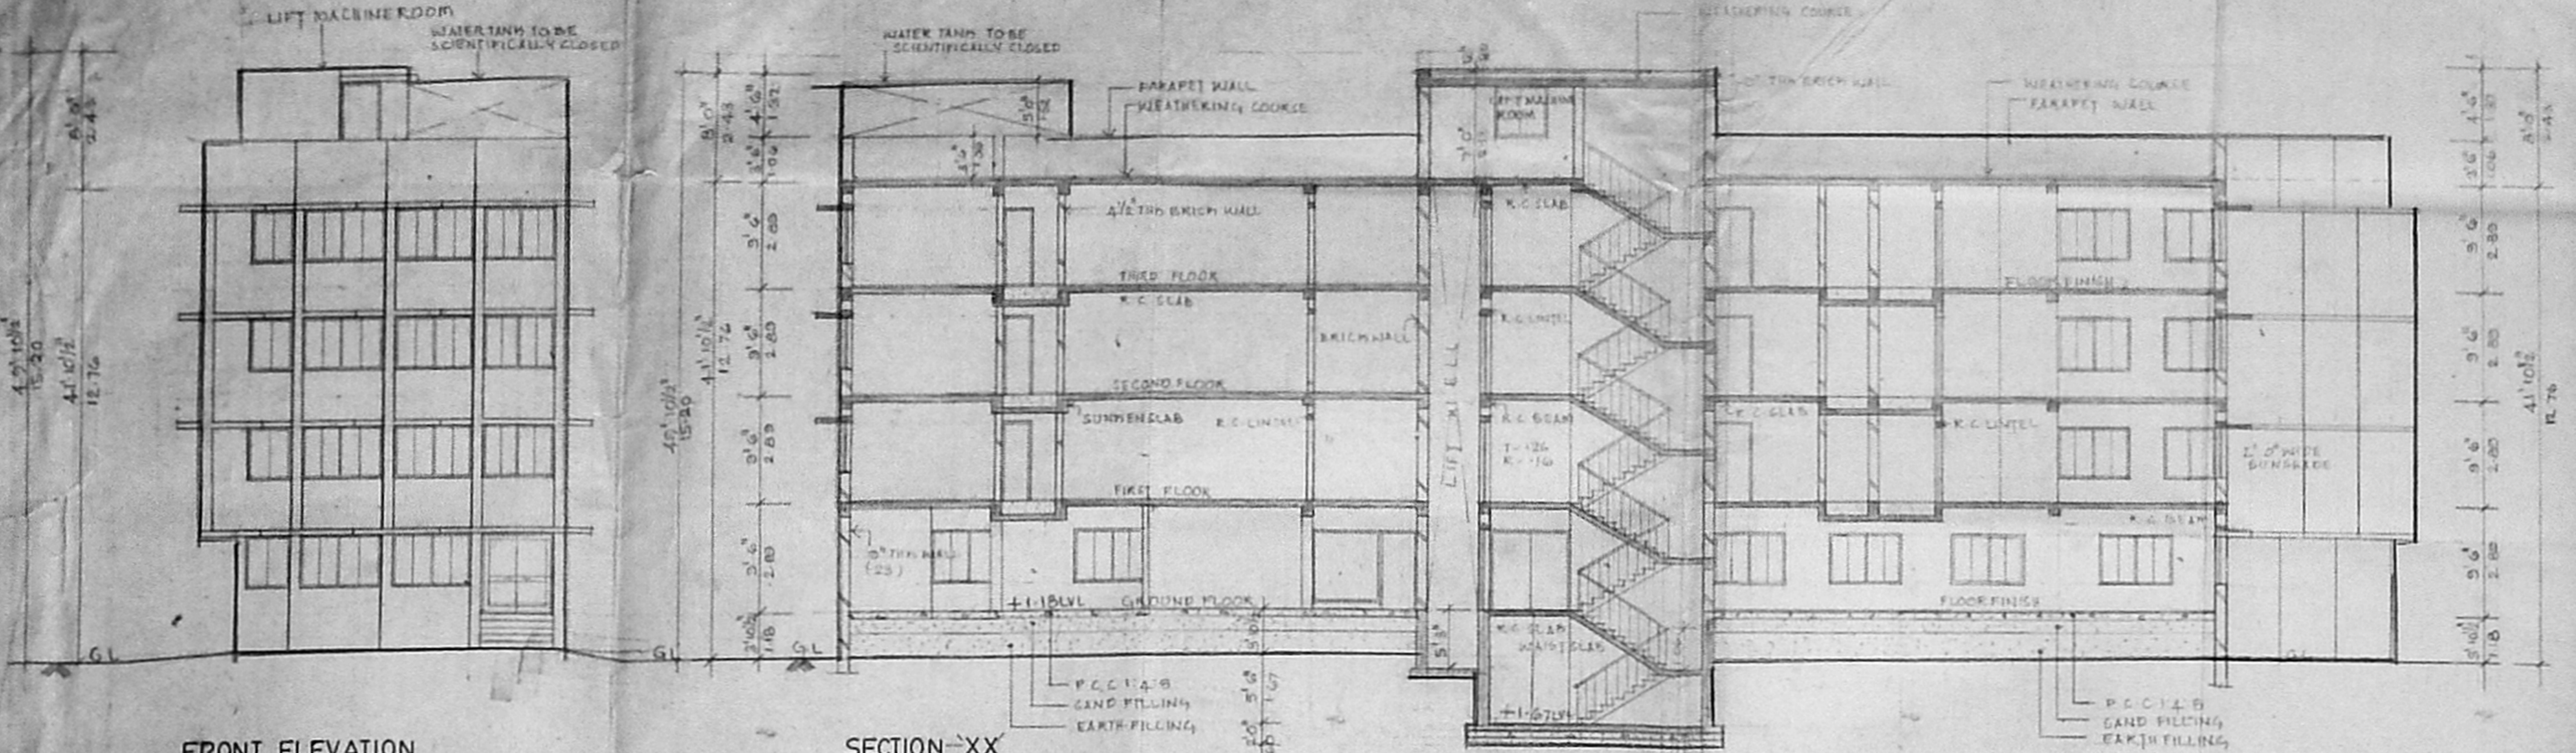


GROUND FLOOR PLAN SCALE: 1:100 (1' 0" 0")

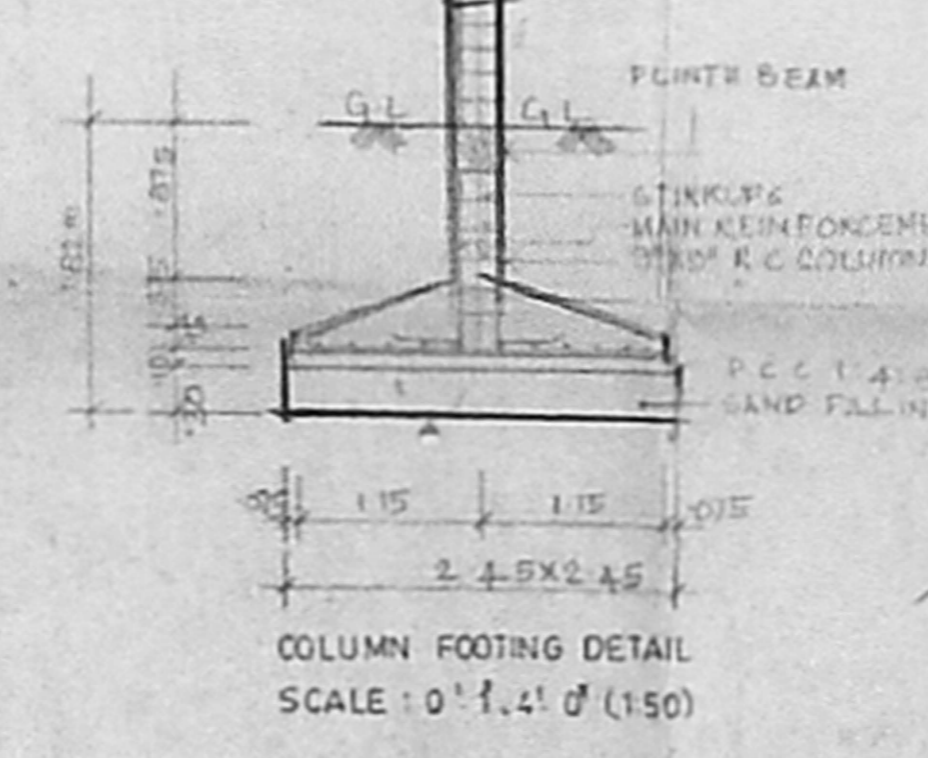

COLUMN FOOTING DETAIL SCALE: 0' 1" 0" (1:50)

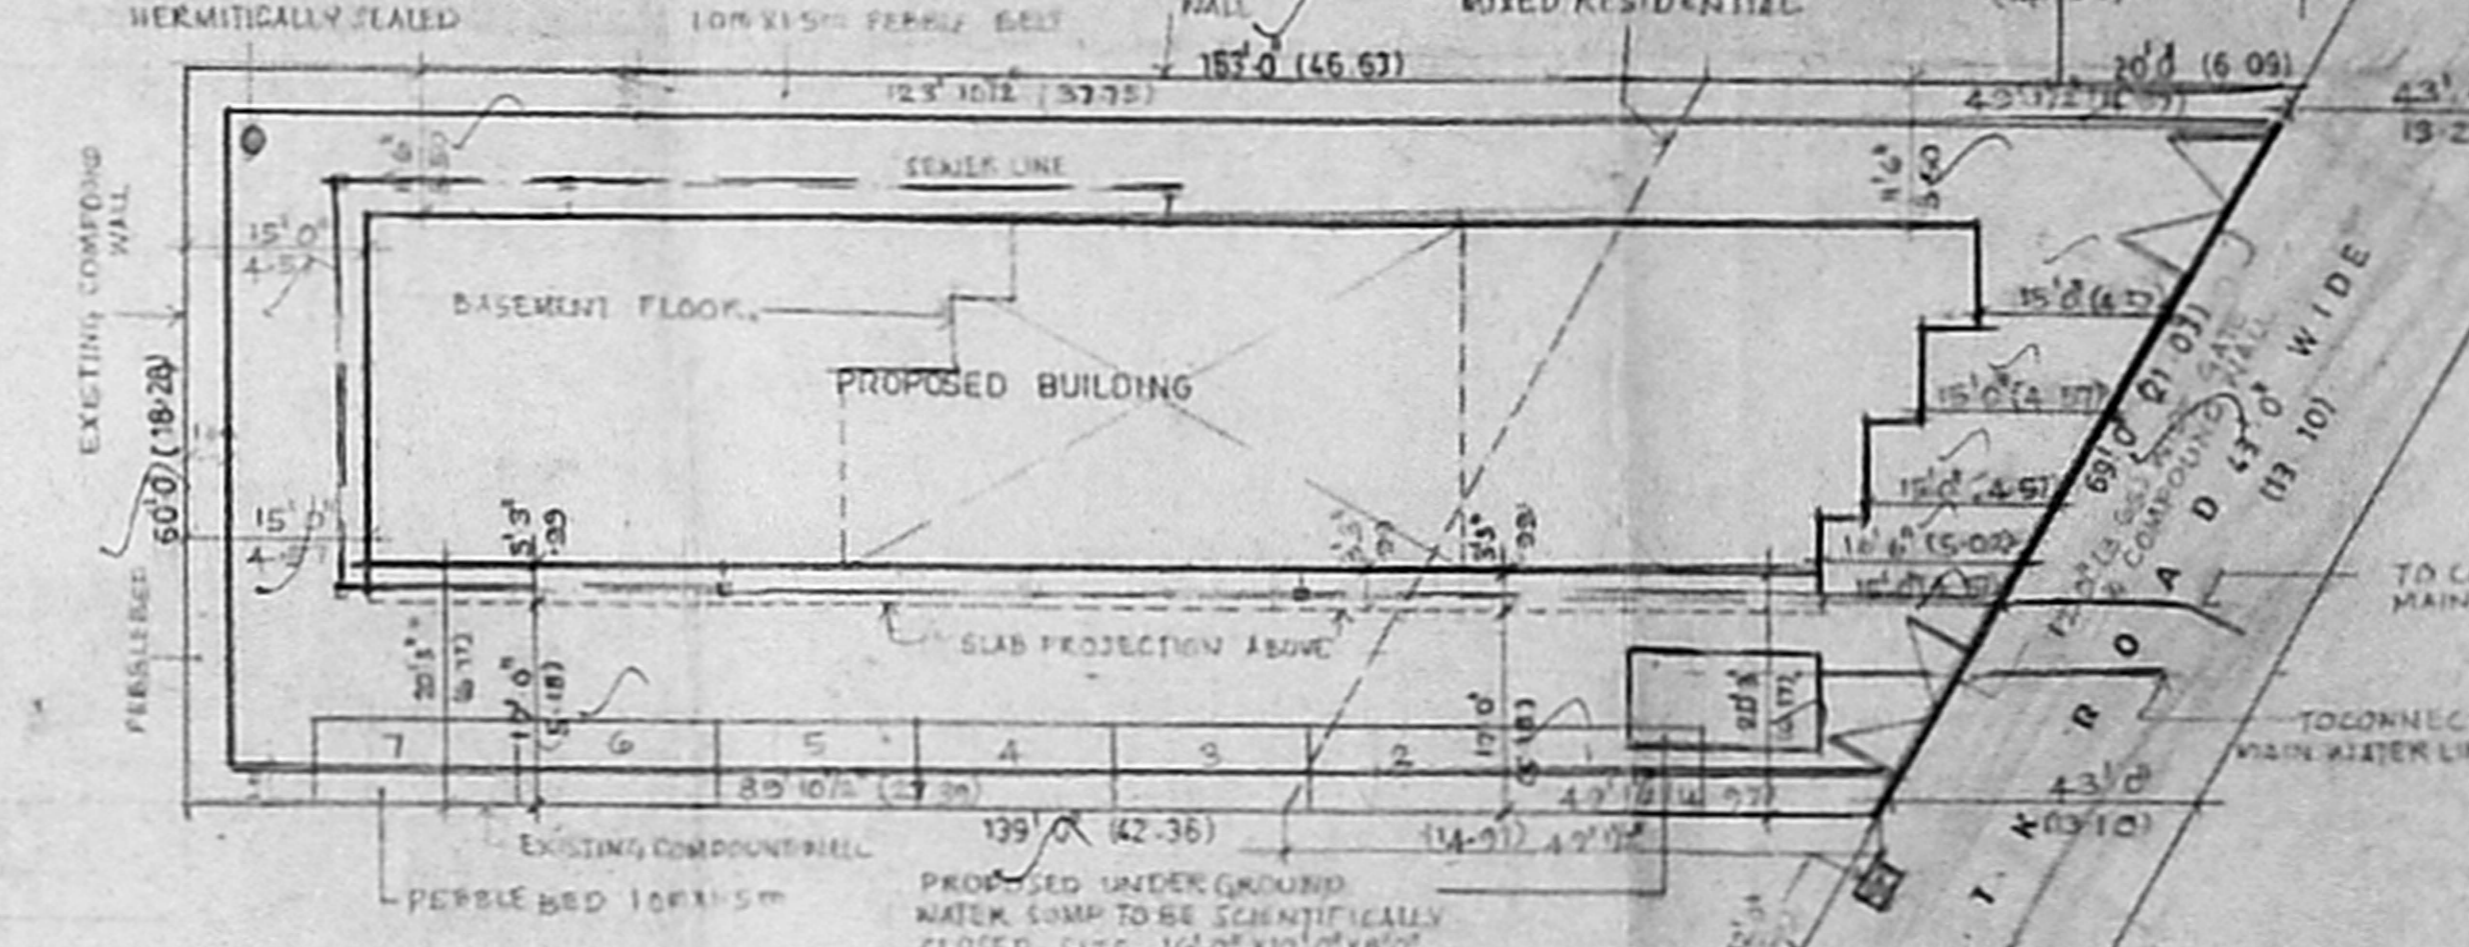

SITE PLAN SCALE: 0' 1" 16" 0" (1:200)

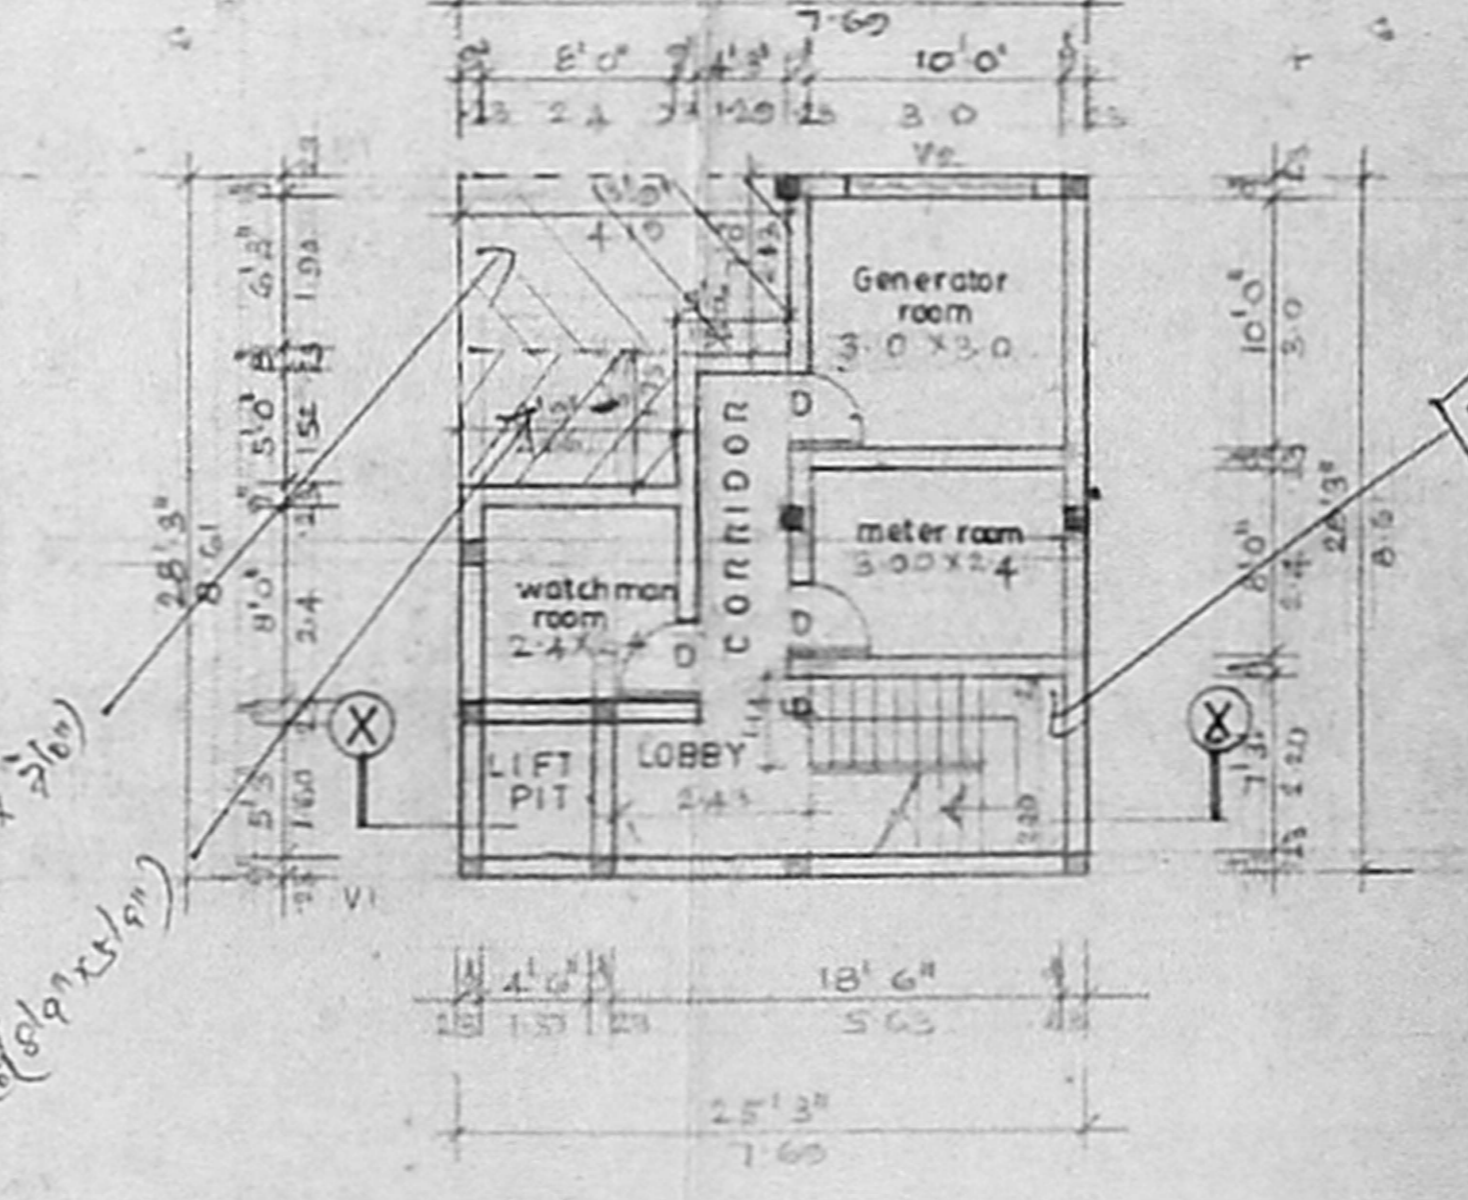

BASEMENT FLOOR PLAN SCALE: 1' 0" 0" (1:100)

Planning Permit No. 2/18990/32

APPROVED

SUBJECT TO THE CONDITIONS IN THIS OFFICE LETTER.

No. 2/18990/32

FOR MEMBER SECRETARY
MADRAS METROPOLITAN
DEVELOPMENT AUTHORITY
MADRAS - 600 008.

21/07/95